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REV.

DRAWING INDEX

DRAWING TITLE

COVER SHEET & DRAWING INDEX

EROSION & SEDIMENT CONTROL PLAN & DETAILS

STORMWATER CONCEPT DESIGN DETAILS SHEET

88 HELEN STREET, SEFTON STORMWATER CONCEPT DESIGN



NOT TO SCALE
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ARCHITECT

CLIENT

DWG. No.

S01-SW201

S01-SW301

S01-SW401

LGA

PREPARED BY

SGC

S&G CONSULTANTS PTY LTD SUITE 311, LEVEL 3 480 PACIFIC HIGHWAY ST. LEONARDS, N.S.W. 2065 T: +61 2 8883 4239


Email: office@sgce.com.au Web: www.sgce.com.au GELDER GROUP ARCHITECTS LA SALLE GROUP



ISSUED FOR DA

Project No. 20240057 Drawing No. S01-SW100 Revision No. A



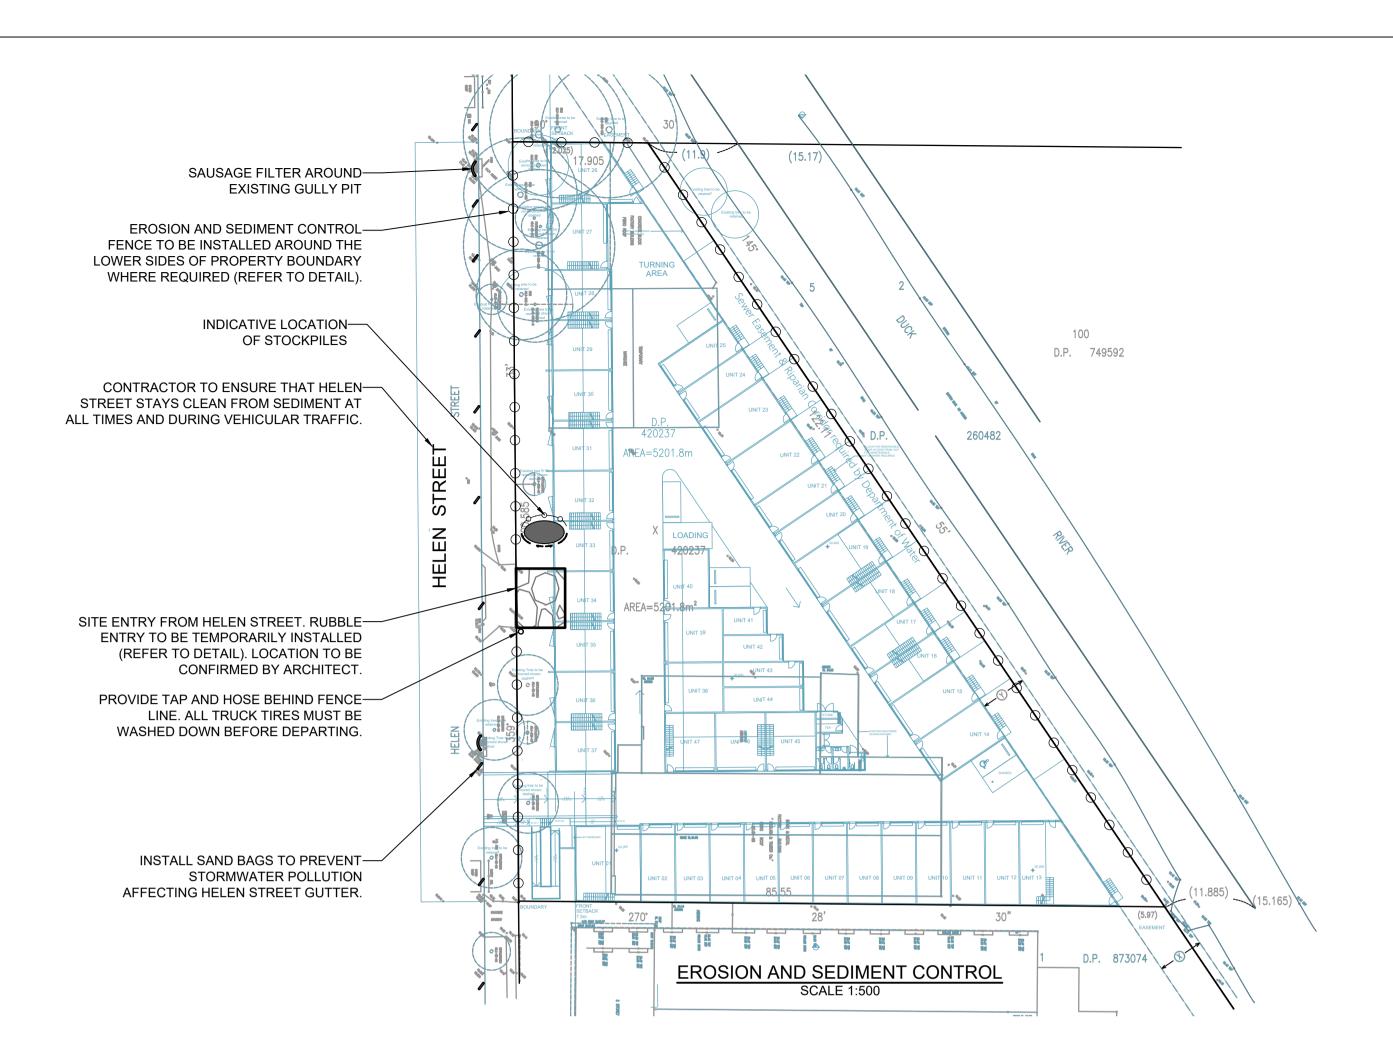

GENERAL NOTES

- 1. THIS PLAN IS A CONCEPT PLAN ONLY FOR STORMWATER DISPOSAL & EROSION CONTROL. IT IS NOT SUITABLE FOR CONSTRUCTION. THIS PLAN SHOULD BE ADAPTED BY THE BUILDER DURING DEMOLITION, EXCAVATION & CONSTRUCTION PHASES TO ENSURE ADEQUATE PERFORMANCE.
- ALL DRAINAGE LAYOUT & DETAILS ARE DIAGRAMMATIC & INDICATIVE ONLY. ACTUAL LOCATION, SIZES, LEVELS & GRADES MAY ALTER WHEN DETAIL DESIGN WORKS ARE DOCUMENTED.


GEOTEXTILE INLET FILTER

GEOTEXTILE INLET FILTER IS PLACED IN EVERY PIT WITHIN THE SITE TO ENSURE THE RUNOFF WATER DURING CONSTUCTION NOT ENTER THE PITS.


CLAY SOILS

A SYSTEM SHALL BE INSTALLED TO EITHER:


- 1. TRANSPORT STORMWATER RUNOFF WITH SUSPENDED SOLIDS FROM SITE VIA PUMP TRUCKS.
- 2. TREAT THE STORMWATER RUNOFF WITH SUSPENDED SOLIDS SO THE DISCHARGE WATER QUALITY TO COUNCIL STORMWATER DRAINAGE SYSTEM HAS A MAXIMUM CONCENTRATION OF SUSPENDED SOLIDS THAT DOES NOT EXCEED 50 MILLIGRAMS PER LITRE IN ACCORDANCE WITH THE PROTECTION OF THE ENVIRONMENT OPERATION ACT (POEO 1997) AND SHALL BE APPROVED BY LOCAL COUNCIL.

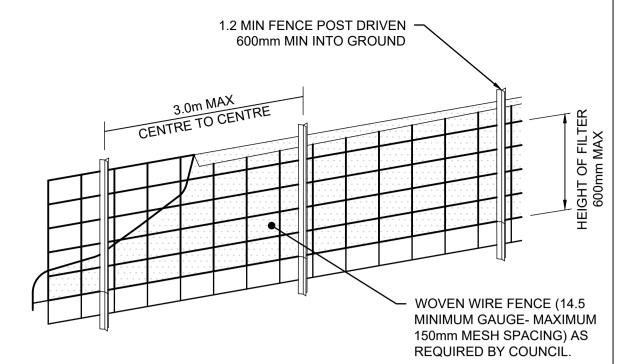

DIAGRAMMATIC VIEW

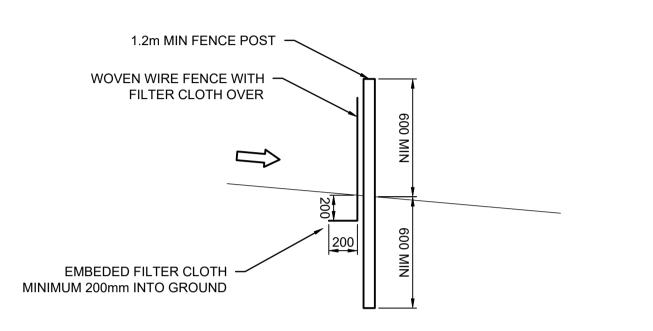

TYPICAL SECTION

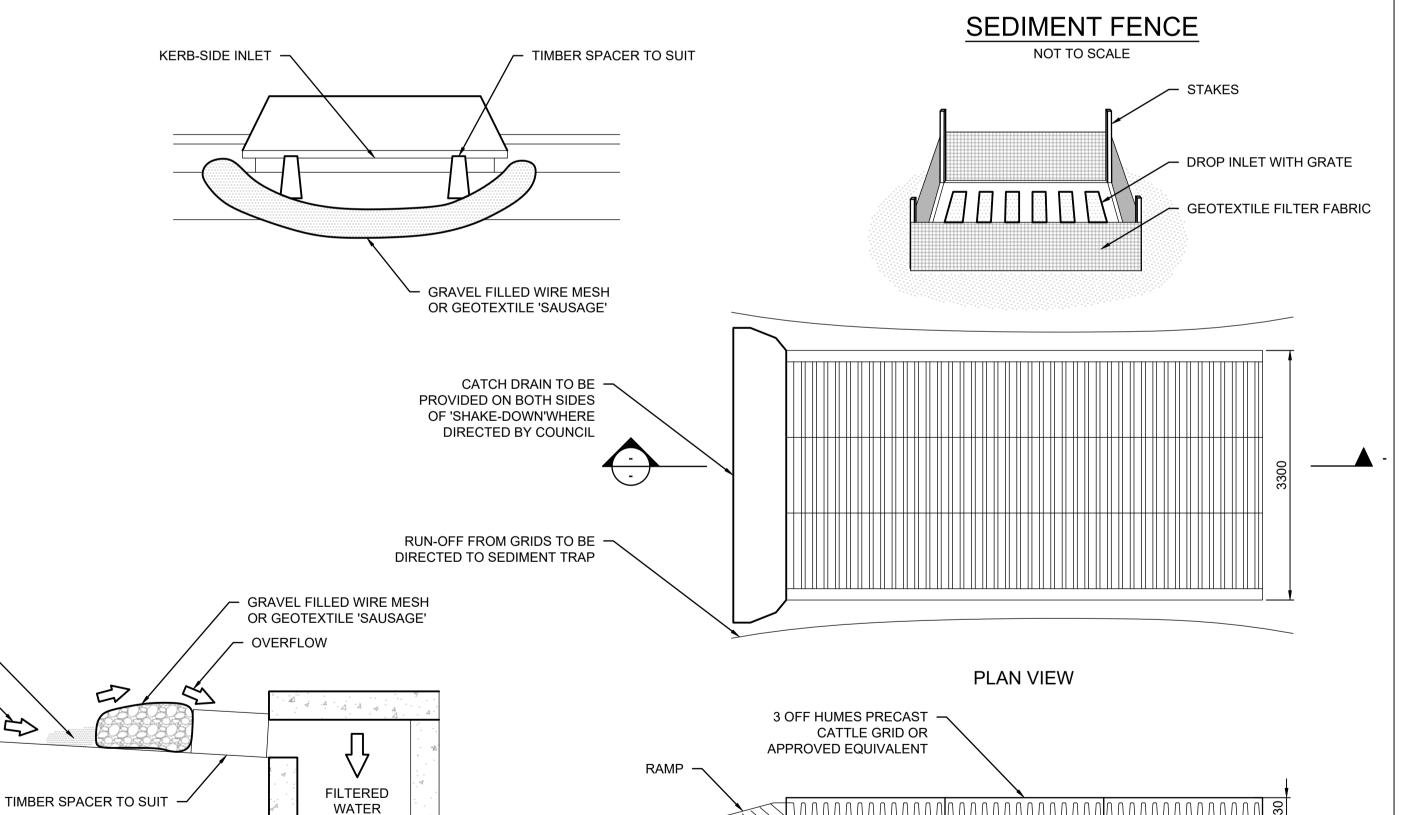

CONSTRUCTION NOTES

FABRICATE A SLEEVE MADE FROM GEOTEXTILE OR WIRE MESH LONGER THAT THE LENGTH OF THE INLET PIT

FILL THE SLEEVE WITH 25mm TO 50mm

GRAVEL

FORM AN ELLIPTICAL CROSS-SECTION OF THE KERB INLET LEAVING A 100mm GAP AT THE TOP TO ACT AS AN EMERGENCY SPILLWAY


MAINTAIN THE OPENING WITH SPACER BLOCKS

FORM A SEAL WITH THE KERBING AND PREVENT SEDIMENT BYPASSING THE FILTER

FIT TO ALL KERB INLETS AT SAG POINTS

EROSION & SEDIMENTATION CONTROL NOTES

- CONTRACTOR SHALL PROVIDE SEDIMENT FENCING MATERIAL DURING CONSTRUCTION TO THE LOW SIDE OF THE WORKS. TIE SEDIMENT FENCING MATERIAL TO CYCLONE WIRE SECURITY FENCE. SEDIMENT CONTROL FABRIC SHALL BE AN APPROVED MATERIAL (EG. HUMES PROPEX SILT STOP) STANDING 300mm ABOVE GROUND & EXTENDING 150mm BELOW GROUND.
- 2. EXISTING DRAINS LOCATED WITHIN THE SITE SHALL ALSO BE ISOLATED BY SEDIMENT FENCING MATERIAL.
- 3. NO PARKING OR STOCKPILING OF MATERIALS IS PERMITTED ON THE LOWER SIDE OF THE SEDIMENT FENCE.
- 4. GRASS VERGES SHALL BE MAINTAINED AS MUCH AS PRACTICAL TO PROVIDE A BUFFER ZONE TO THE CONSTRUCTION SITE.
- 5. CONSTRUCTION ENTRY/EXIT SHALL BE VIA THE LOCATION NOTED ON THE DRAWING. CONTRACTOR SHALL ENSURE ALL DROPPABLE SOIL & SEDIMENT IS REMOVED PRIOR TO CONSTRUCTION TRAFFIC EXITING SITE. CONTRACTOR SHALL ENSURE ALL CONSTRUCTION TRAFFIC ENTERING & LEAVING THE SITE DO SO IN A FORWARD DIRECTION.

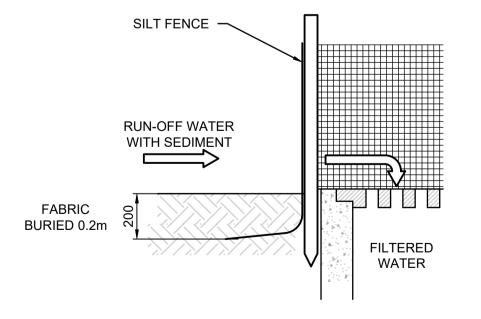

GEOTEXTILE INLET FILTER

NOT TO SCALE

GRAVEL INLET FILTER (SAUSAGE)
NOT TO SCALE

TYPICAL SECTION

'CATTLE GRID' ALTERNATIVE

2100

2100

2100

		Ctatus
	TEMPORARY CONSTRUCTION	IN EXIT - NOT TO SCALE
	TEMPODARY CONSTRUCTION	NI EVIT NOT TO SCALE

50mm THICK


GRANULAR BEDDING


Reference	Coordination Drawing	Quality Control	ENGINEERS AUSTRALIA	Scales	Client	Architect		S&G CONSULTANTS PTY LTD	PROJECT	Status ISSUED FOR DA
Discipline Dr		DRAWN DATE CS 09.04.25 CHECKED DATE SH 09.04.25 DESIGNED DATE CS 09.04.25	Chartered Professional Engineer MEMBER WARNING: THE DESIGNS, DRAWINGS, SPECIFICATIONS AND THE COPYRIGHT HEREIN REMAIN THE SOLE INTELLECTUAL PROPERTY OF S&G CONSULTANTS PTY LTD AND MUST NOT BE USED, COPIED, ALTERED OR REPRODUCED WHOLLY OR IN PART IN ANY FORM WITHOUT THE WRITTEN CONSENT OF S&G CONSULTANTS PTY LTD DIMENSIONS NOT SHOWN TO BE CHECKED ON SITE. DO NOT SCALE	0 <u>m 5 10 15 20 2</u> 5 SCALE 1:500 ON ORIGINAL SIZE	LA SALLE GROUP	GELDER GROUP ARCHITECTS		SUITE 311, LEVEL 3 480 PACIFIC HIGHWAY ST. LEONARDS, N.S.W. 2065 T: +61 2 8883 4239	88 HELEN STREET,	Drawing Title EROSION & SEDIMENT CONTROPLAN & DETAILS
Same Last revision title By Date Status FIRE Issuer internal sequence and revision history -preliminary -preliminary -tender 2-development application -tender 3-construction certificate 6-other SURVEY		VERIFIED DATE SH 09.04.25 APPROVED DATE	OF THIS DRAWING. POSITIONS OF AUTHORITIES MAINS AND/OR EXISTING SERVICES ARE TO BE CHECKED PRIOR TO COMMENCEMENT OF WORK. REPORT ANY DISCREPANCIES TO THE CONSULTING ENGINEER FOR DECISION/CLARIFICATION BEFORE PROCEEDING WITH THE WORK. THIS DRAWING IS TO BE READ IN CONJUNCTION WITH THE SPECIFICATIONS AND OTHER CONSULTANTS' DRAWINGS.				SGC	A.B.N. 21 118 222 530	Grid Datum Sheet A.H.D. 02	Project No. Set No Drg No. Revision 20240057 S01-SW201 A

SEDIMENT

RUNOFF WATER

WITH SEDIMENT

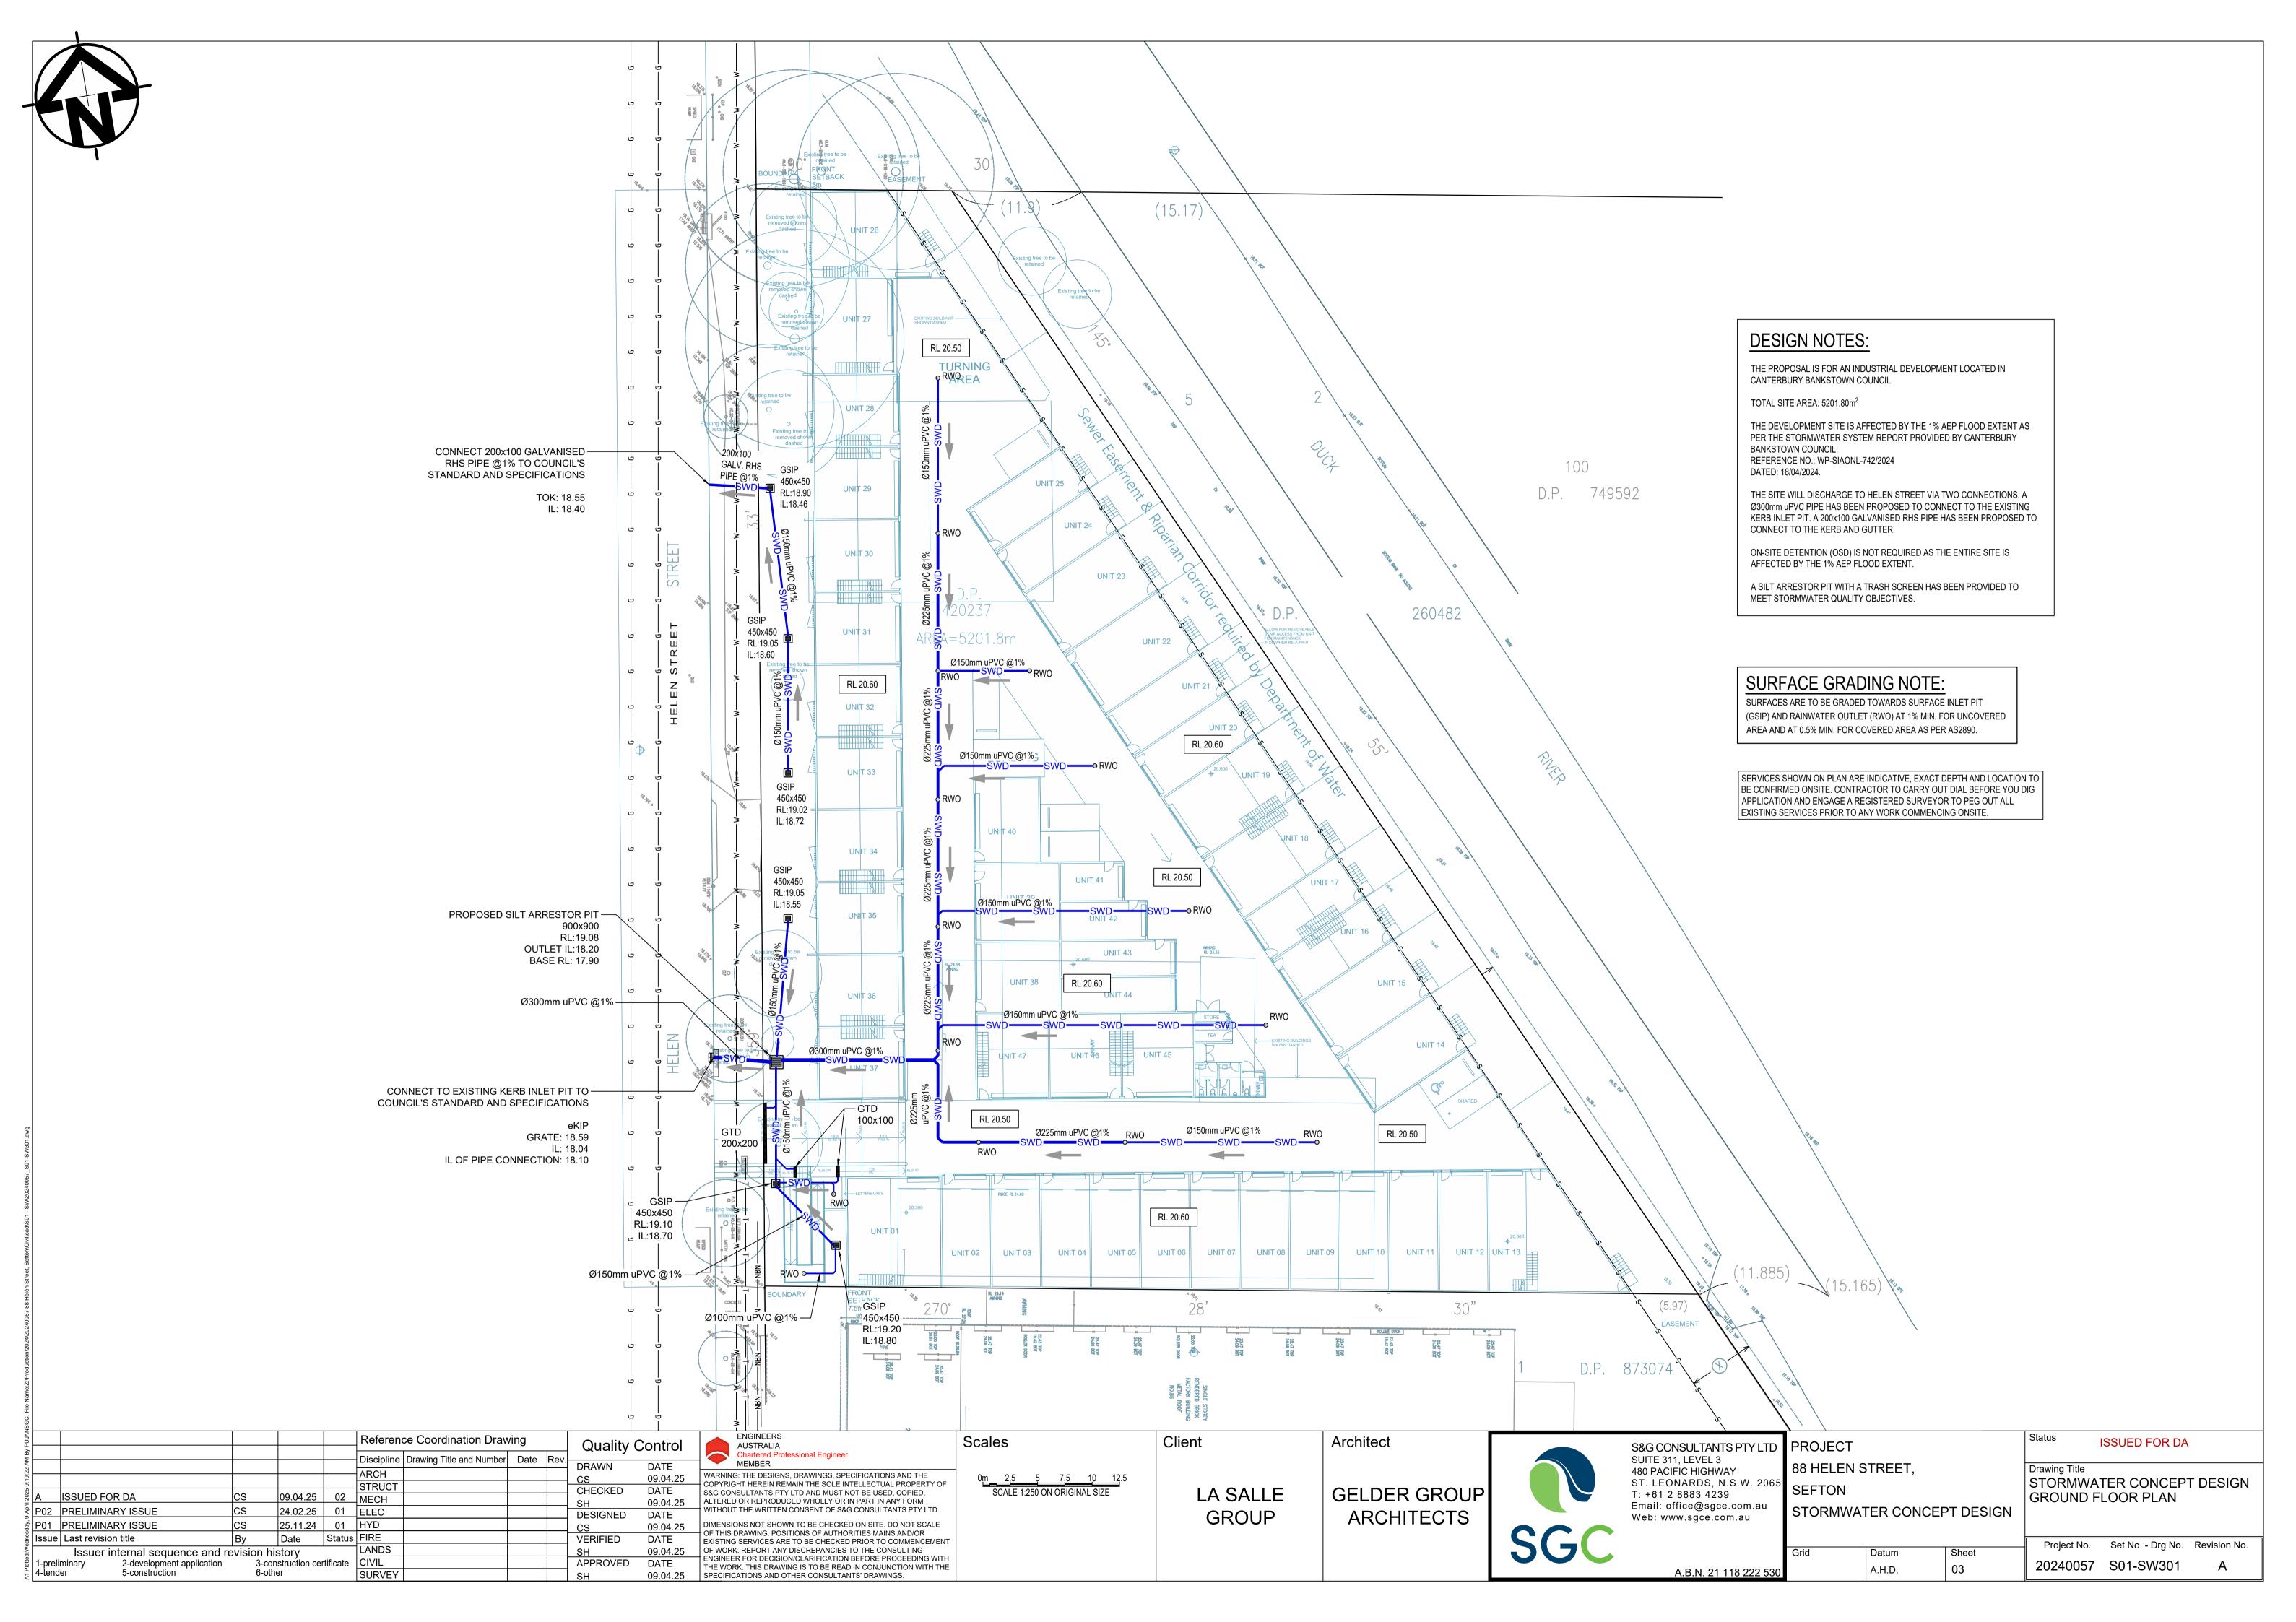

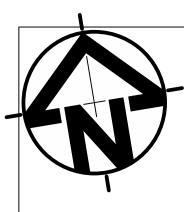



ENGINEERS
AUSTRALIA
Chartered Professional Engineer
MEMBER Reference Coordination Drawing ISSUED FOR DA S&G CONSULTANTS PTY LTD PROJECT Discipline Drawing Title and Number Date Rev. SUITE 311, LEVEL 3 88 HELEN STREET, DRAWN 480 PACIFIC HIGHWAY ST. LEONARDS, N.S.W. 2065 Drawing Title ARCH WARNING: THE DESIGNS, DRAWINGS, SPECIFICATIONS AND THE COPYRIGHT HEREIN REMAIN THE SOLE INTELLECTUAL PROPERTY OF 0<u>m 2,5 5 7,5 10 12</u>.5 SCALE 1:250 ON ORIGINAL SIZE 09.04.25 STORMWATER CONCEPT DESIGN STRUCT SEFTON **GELDER GROUP** LA SALLE T: +61 2 8883 4239
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Web: www.sgce.com.au CHECKED DATE S&G CONSULTANTS PTY LTD AND MUST NOT BE USED, COPIED, ALTERED OR REPRODUCED WHOLLY OR IN PART IN ANY FORM WITHOUT THE WRITTEN CONSENT OF S&G CONSULTANTS PTY LTD ROOF PLAN 09.04.25 02 MECH ISSUED FOR DA 09.04.25 STORMWATER CONCEPT DESIGN P02 PRELIMINARY ISSUE 24.02.25 01 ELEC ARCHITECTS GROUP DATE DESIGNED DATE

09.04.25

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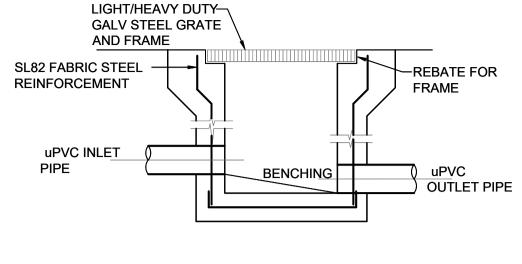
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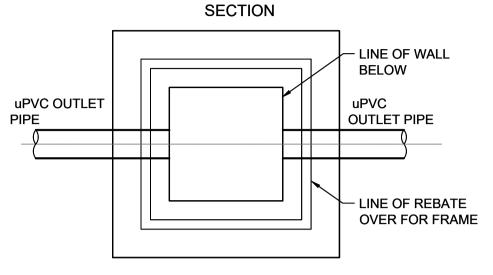
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O9.04.25 25.11.24 01 HYD P01 PRELIMINARY ISSU Status FIRE Issue Last revision title Date VERIFIED Project No. Set No. - Drg No. Revision No. LANDS Issuer internal sequence and revision history 3-construction certificate CIVIL 2-development application 5-construction 1-preliminary 4-tender 20240057 S01-SW302 APPROVED A.H.D. A.B.N. 21 118 222 530 6-other SURVEY





GRATED TRENCH DRAIN N.T.S.


HEAVY DUTY -GALVANISED

STEEL GRATE MINIMUM 1% GRADE

BASE FALL TO OUTLET

FINISHED -

LEVEL

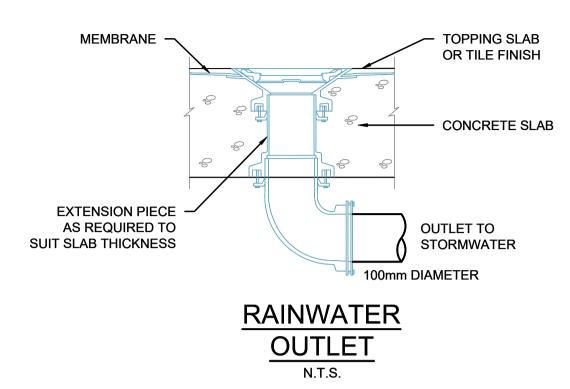

SITEWORKS LEGEND

— SWRM —— SWRM ——

RWO

O CO

DDO

PD

DP

◆ 00.00

STORMWATER LINE

STORMWATER RISING MAIN

AUTHORITY SEWER LINE

AUTHORITY WATER LINE

AUTHORITY COMMS LINE

GRATED SURFACE INLET PIT

GRATED SURFACE INLET PIT WITH ENVIROPOD INSERT

GRATED TRENCH DRAIN

RAINWATER OUTLET

CLEAR OUT POINT

DISH DRAIN OUTLET

PLANTER DRAIN

DOWNPIPE DROP

WARNING LIGHT

FINISH SURFACE LEVEL

DOWNPIPE

JUNCTION PIT

AUTHORITY GAS LINE

SUBSOIL LINE


STORMWATER LINE TO RAINWATER TANK

AUTHORITY OVER HEAD ELECTRICITY LINE


AUTHORITY UNDERGROUND ELECTRICITY LINE


STORMWATER PIT N.T.S.


PLAN WITHOUT GRATE

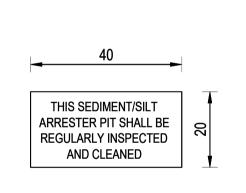


SILT ARRESTER SIGN

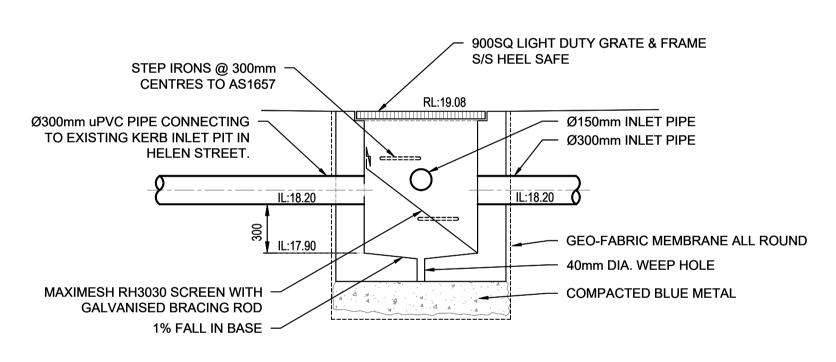

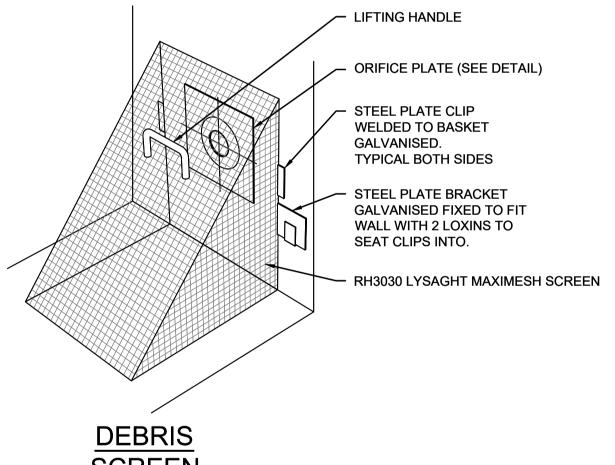

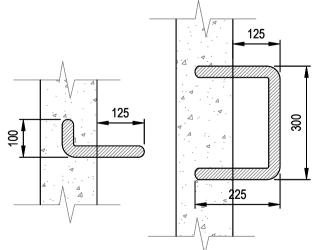

<u>STEP</u> <u>IRONS</u> N.T.S.

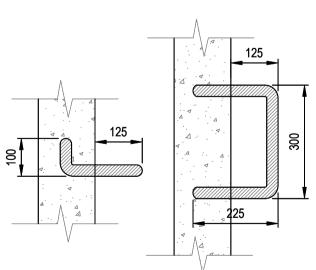

ABBREVIATIONS: SILT ARRESTOR PIT DIAMETER Ø or DIA SCREEN **CLEAR OUT** CO DDO DISH DRAIN OUTLET DP DOWNPIPE **EXISTING** FFL FINISHED FLOOR LEVEL GTD GSIP GRATED TRENCH DRAIN GRATED SURFACE INLET PIT **INVERT LEVEL** KERB INLET PIT KIP NATURAL GROUND LEVEL OVERLAND FLOWPATH NGL OFP OSD ON-SITE DETENTION RCP REINFORCED CONCRETE PIPE REDUCED LEVEL RL RAINWATER TANK RWT STORMWATER SW STORMWATER PIT SWP SWRM STORMWATER RISING MAIN SWS TOK TOW STORMWATER SUMP TOP OF KERB TOP OF WALL UPVC

NPTON K	Reference Coordination Drav	wing Quality Control	ENGINEERS AUSTRALIA	Scales	Client	Architect		S&G CONSULTANTS PTY LTD	PROJECT		Status ISSUED FOR DA
	Discipline Drawing Title and Number ARCH STRUCT 02 MECH 01 ELEC	Date Rev. DRAWN DATE CS 09.04.25 CHECKED DATE SH 09.04.25 DESIGNED DATE	Chartered Professional Engineer MEMBER WARNING: THE DESIGNS, DRAWINGS, SPECIFICATIONS AND THE COPYRIGHT HEREIN REMAIN THE SOLE INTELLECTUAL PROPERTY OF S&G CONSULTANTS PTY LTD AND MUST NOT BE USED, COPIED, ALTERED OR REPRODUCED WHOLLY OR IN PART IN ANY FORM WITHOUT THE WRITTEN CONSENT OF S&G CONSULTANTS PTY LTD		LA SALLE GROUP	GELDER GROUP ARCHITECTS		SUITE 311, LEVEL 3 480 PACIFIC HIGHWAY ST. LEONARDS, N.S.W. 2065 T: +61 2 8883 4239	88 HELEN STREET.	PT DESIGN	Drawing Title STORMWATER CONCEPT DESIGN DETAILS SHEET
P01 PRELIMINARY ISSUE CS 25.11.24 Issue Last revision title By Date	01 HYD Status FIRE LANDS crtificate CIVIL SURVEY	CS 09.04.25 VERIFIED DATE SH 09.04.25 APPROVED DATE	DIMENSIONS NOT SHOWN TO BE CHECKED ON SITE. DO NOT SCALE OF THIS DRAWING. POSITIONS OF AUTHORITIES MAINS AND/OR EXISTING SERVICES ARE TO BE CHECKED PRIOR TO COMMENCEMENT OF WORK. REPORT ANY DISCREPANCIES TO THE CONSULTING ENGINEER FOR DECISION/CLARIFICATION BEFORE PROCEEDING WITH THE WORK. THIS DRAWING IS TO BE READ IN CONJUNCTION WITH THE SPECIFICATIONS AND OTHER CONSULTANTS' DRAWINGS.		GROUP	ARCHIECIS	SGC	A.B.N. 21 118 222 530	Grid Datum	Sheet 05	Project No. Set No Drg No. Revision No. 20240057 S01-SW401 A